



ISSUED FOR BID

STAIR #1. ISO METRIC IE
 SCALE: N.T.S.


REVISIONS			
No.	DATE	DESCRIPTION	
PROJECT: 452 FT. WASHINGTON AVE. FIRE ESCAPE STAIRS			
TITLE: STAIR #1 ISO METRIC IE			
DRAWN BY: A.B.	DATE	PROJ. No.	DRAWING
CHECKED BY:	May/15/06		S

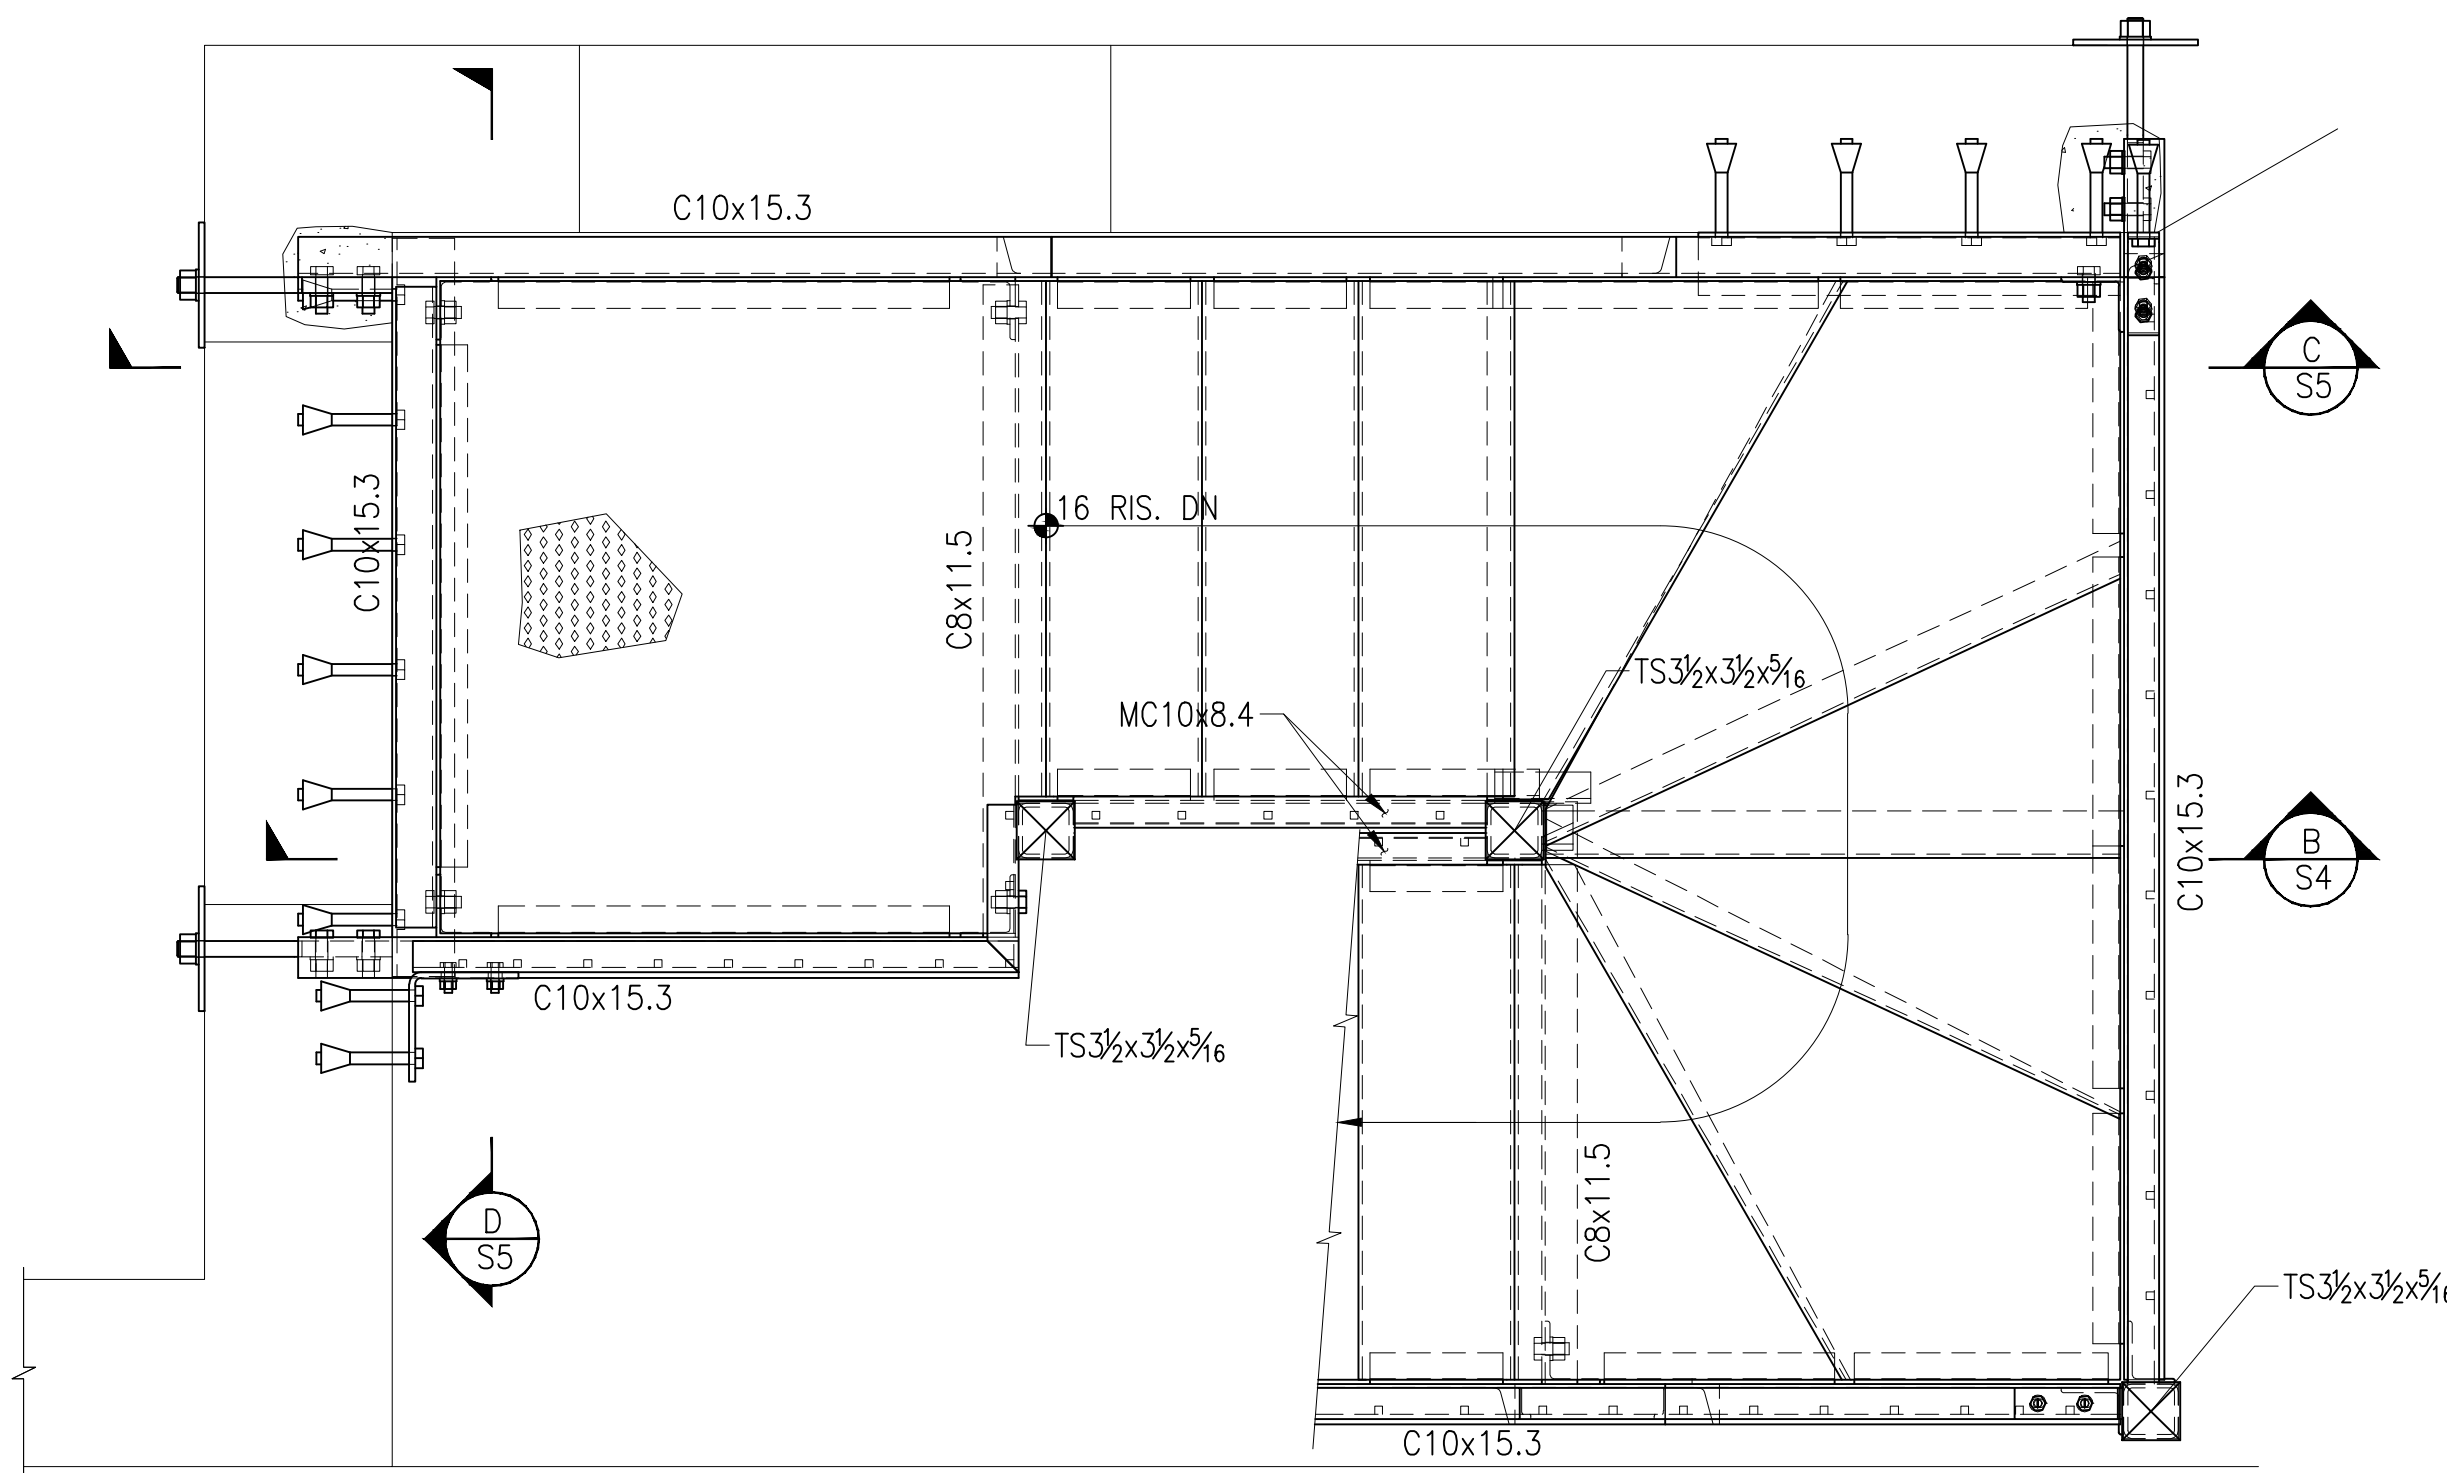


ROOF PLAN
SCALE: 1" = 1'-0"

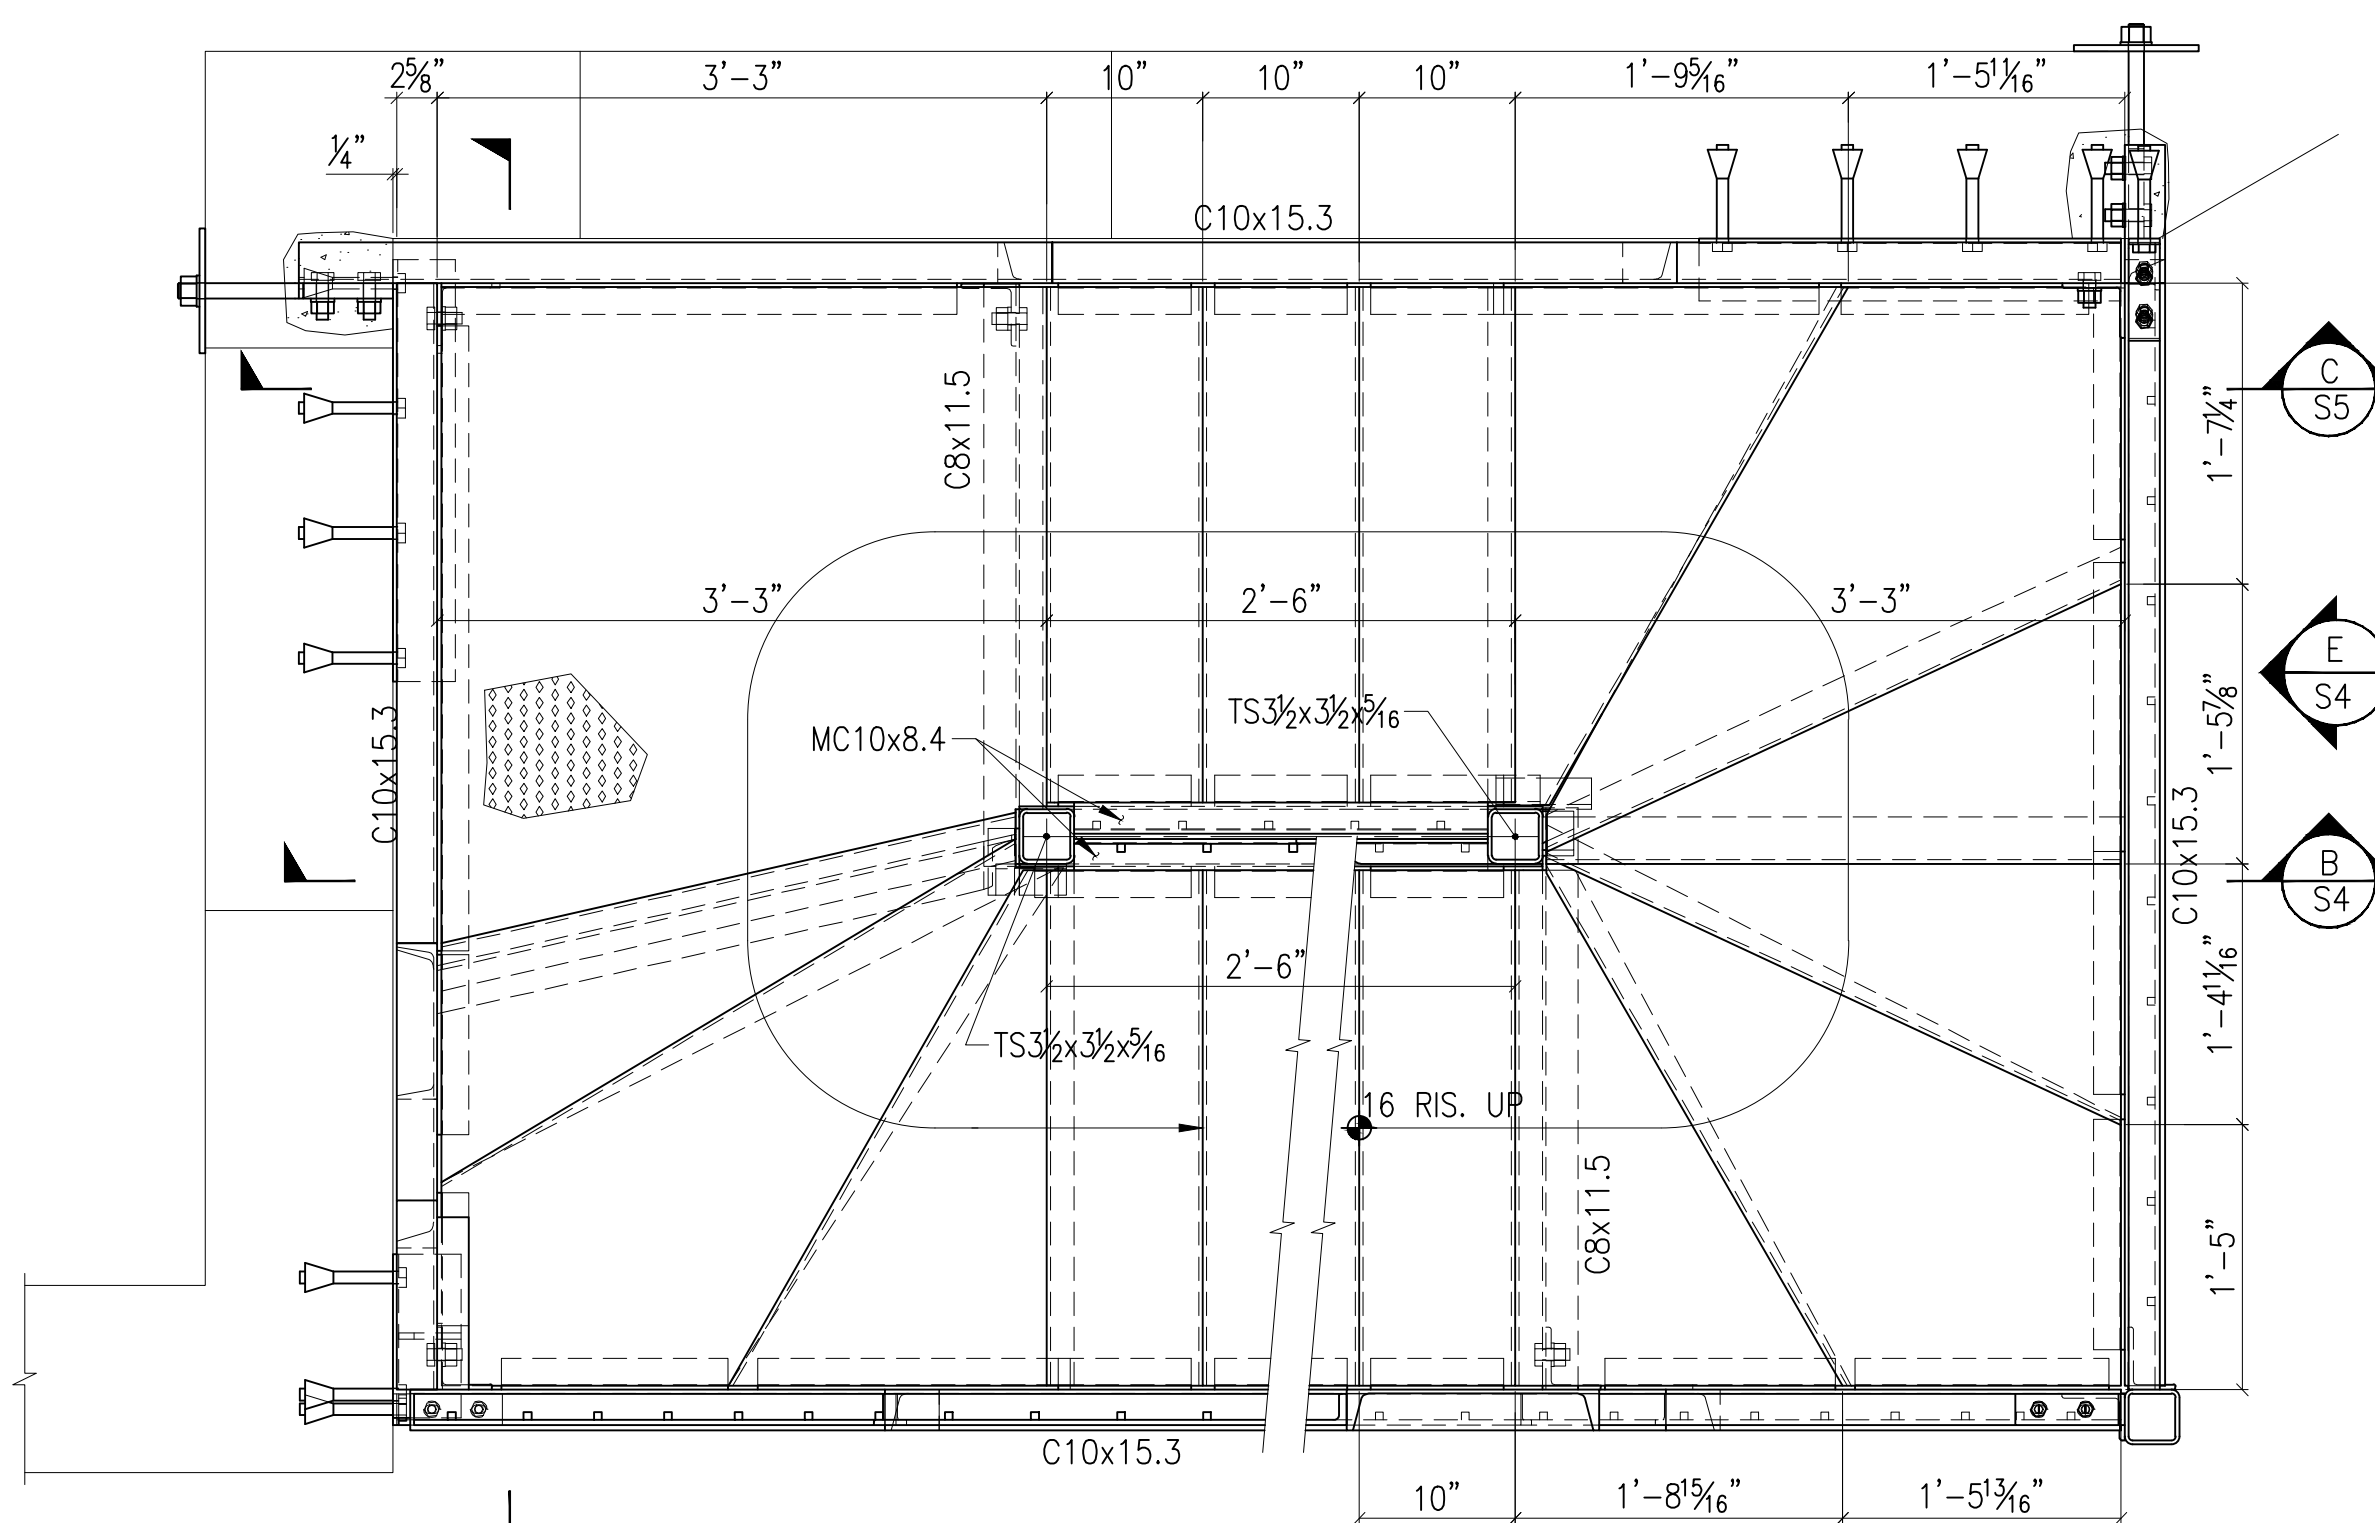

2ND THRU 6TH FLOOR TYP. PLAN
SCALE: 1" = 1'-0"

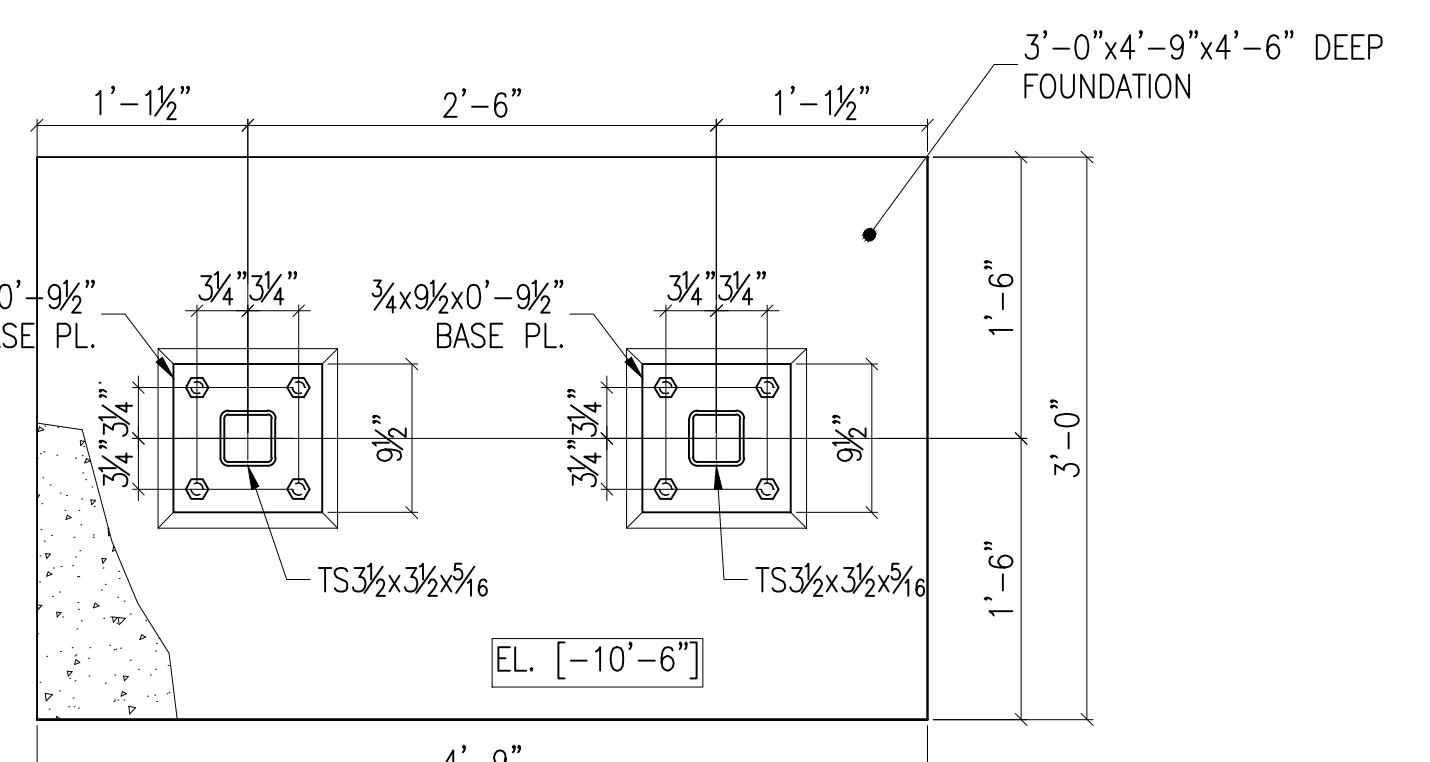

1 DETAIL
SCALE: 1" = 1'-0"

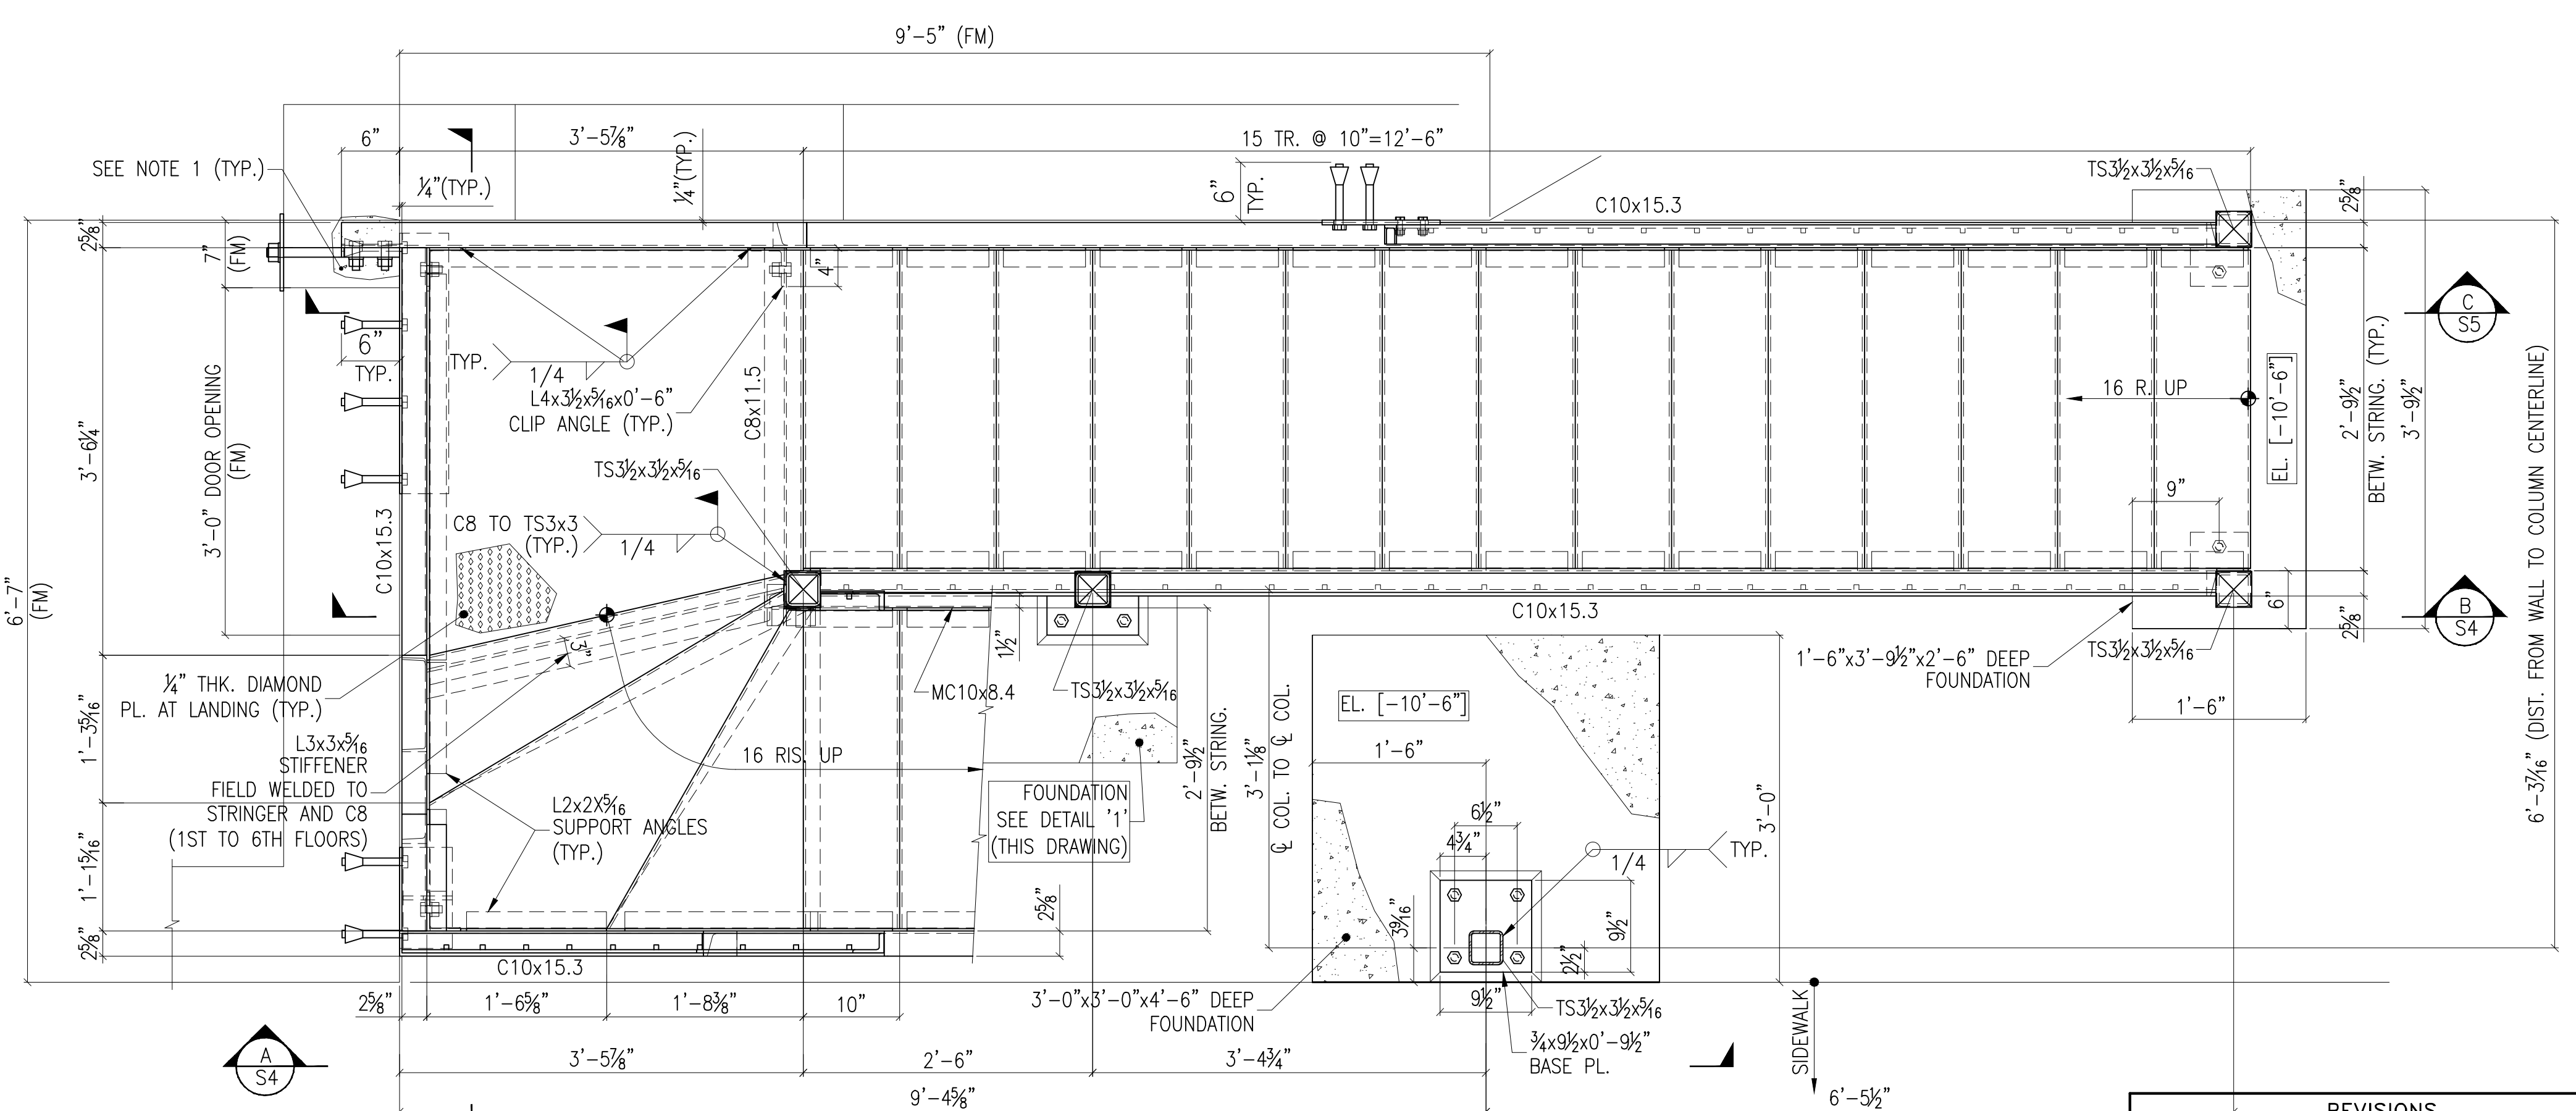

1ST FLOOR PLAN
SCALE: 1" = 1'-0"

NOTE 1.
7"± DEEP WALL POCKET. FILL EXISTING AND NEW ANCHOR ROD POCKETS IN THE MASONRY WITH NONSHRINK CEMENTITIOUS GROUT WITH MINIMUM COMPRESSIVE STRENGTH, FC OF 5000 PSI. CONTRACTOR SHALL FORM AROUND THE POCKET ENTRANCE AREA AND INSTALL PROTECTIVE PLASTIC SHEETS ON THE MASONRY TO PREVENT GROUT RUN MARKS AND STAINS ON THE MASONRY.


REVISIONS		
No.	DATE	DESCRIPTION

PROJECT: 452 FT. WASHINGTON AVE.
FIRE ESCAPE STAIRS


TITLE: STAIR #1
PLANS AND SECTIONS

DRAWN BY: A.B.	DATE	PROJ. No.	DRAWING
CHECKED BY:	Oct/20/06		S3

ISSUED FOR BID


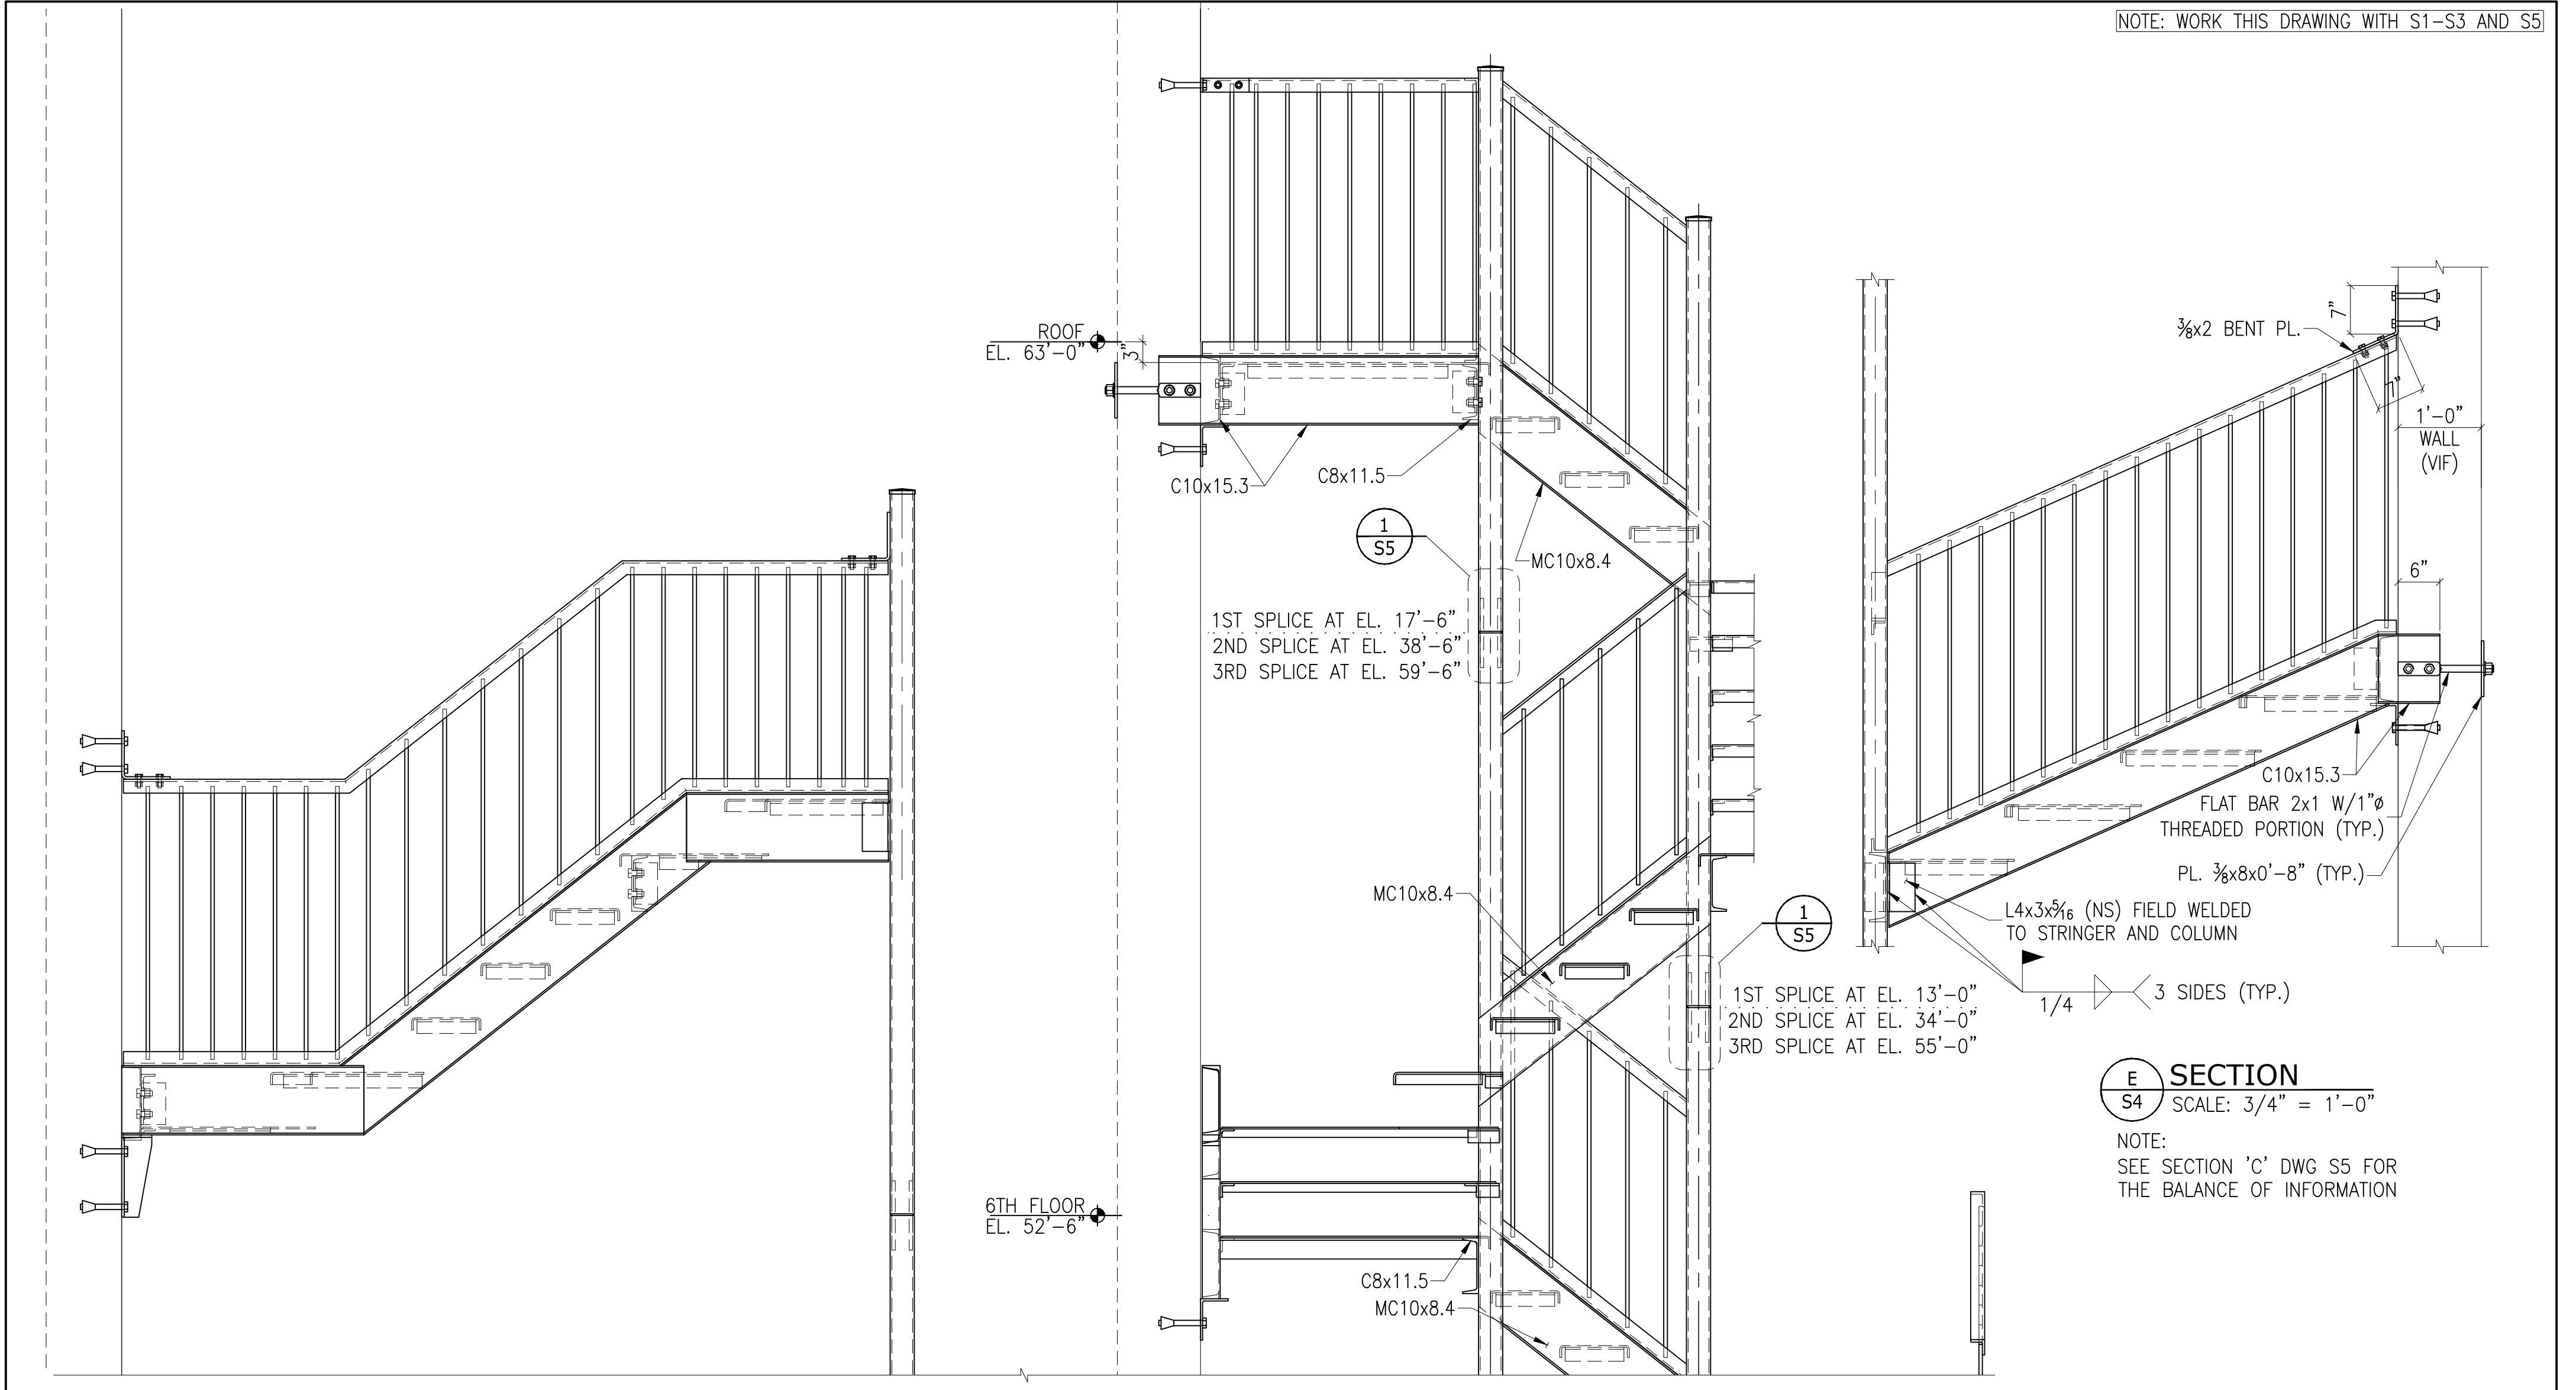


E SECTION
S4 SCALE: 3/4" = 1'-0"
NOTE:
SEE SECTION 'C' DWG S5 FOR
THE BALANCE OF INFORMATION

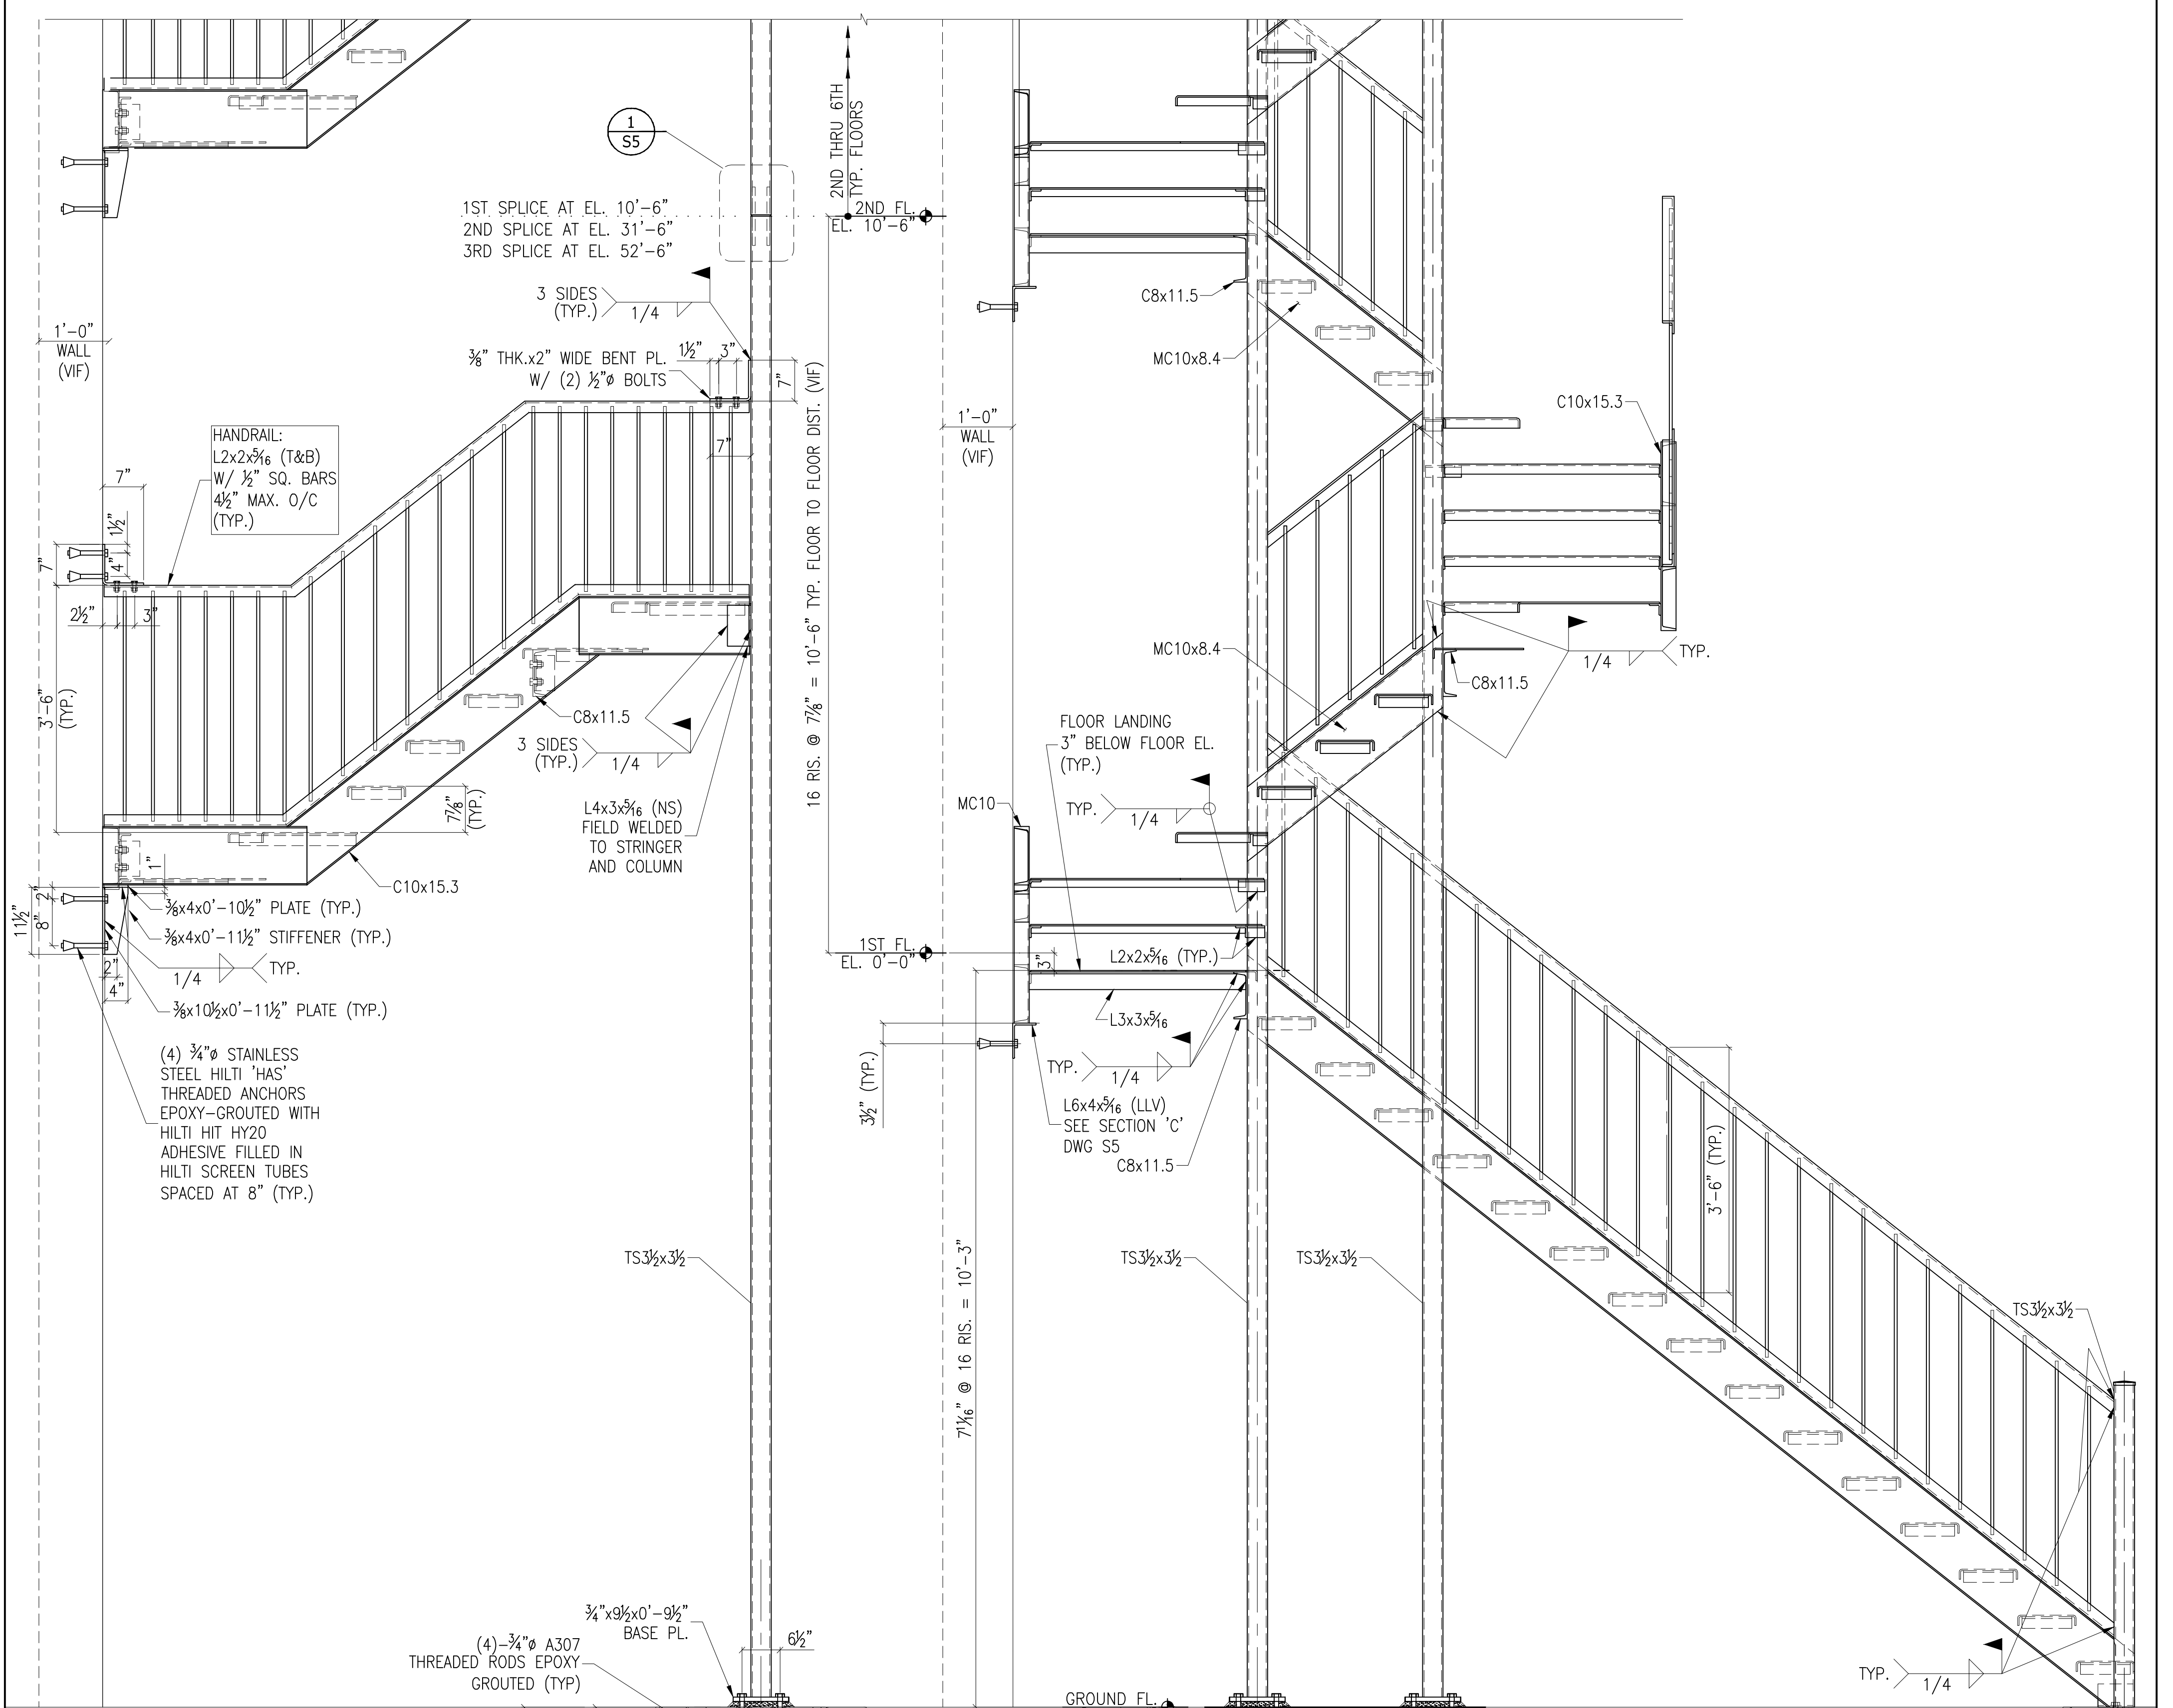

A SECTION
S4 SCALE: 3/4" = 1'-0"

B SECTION
S4 SCALE: 3/4" = 1'-0"

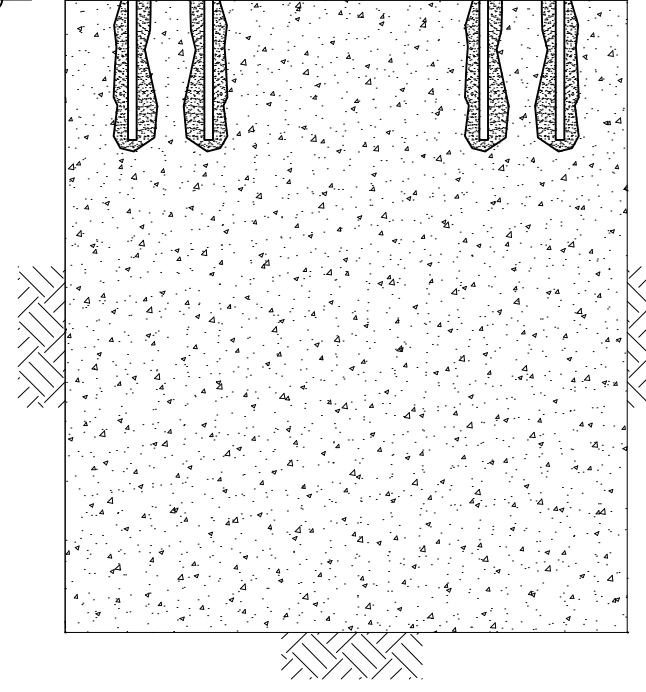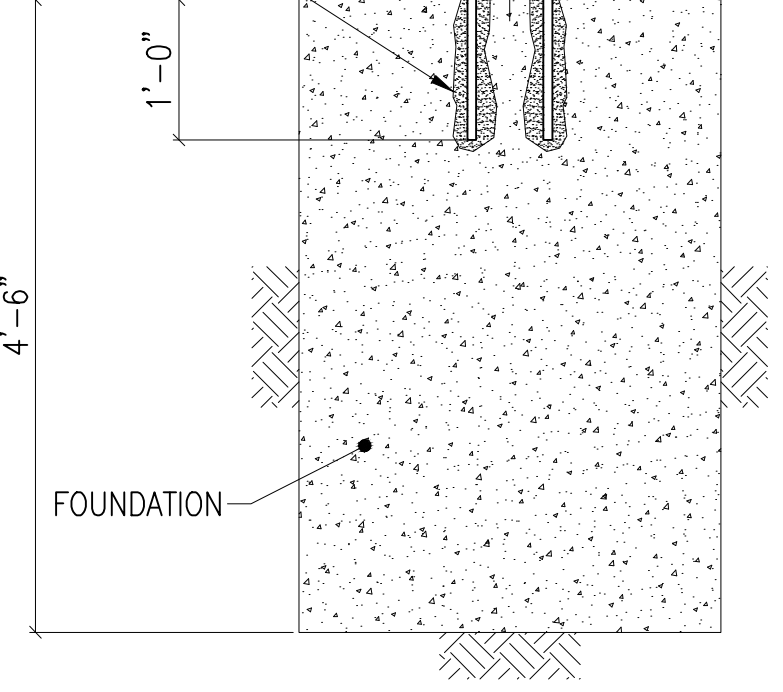

REVISIONS		
No.	DATE	DESCRIPTION

PROJECT: 452 FT. WASHINGTON AVE.
FIRE ESCAPE STAIRS

TITLE: STAIR #1
SECTIONS

DRAWN BY: A.B. DATE: PROJ. No. DRAWING

CHECKED BY: Oct/20/06 S4

ISSUED FOR BID

